

SUNCOAST BUILDING APPROVALS

No: 172400

2 9 SEP 2017

MICHAEL GRUMMETT BSA No: A1021910
DEVELOPMENT APPROVAL
FOR BUILDING WORKS
PH: 5443 7288 MOB: 0407 573 741

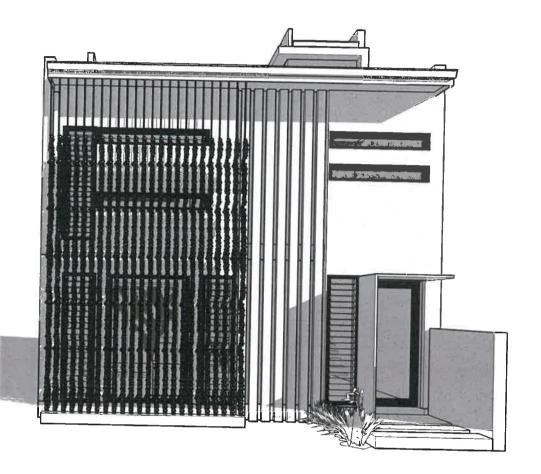

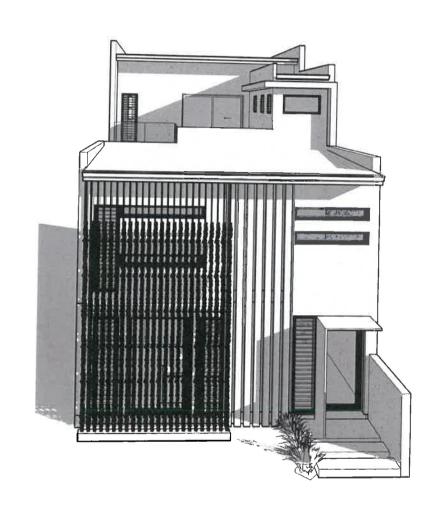

PROPOSED STREET FRONT PERSPECTIVE

Indicative image - survey required to accurately represent the proposed building on site.

TERMITE MANAGEMENT SYSTEM Built to boundary walls

As walls are built to boundary, termite management system required, is that all primary building elements are termite resistant materials to satisfy BCA Volume Two Part 3.1.3 including the Queensland Amendment

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	Revision Schedule		Client Name:	Nothling Building Group			
	Revision Number	Revision Description PCD 2.0	Revision Date	Issued by	Project Address:	Lot 43 Tinnanbar Terrace	
		PCD 3.0	30/03/2017 16/05/2017	BJH	Climate Zone:	2	
1 2		PCD 4.0	23/05/2017	BJH	Wind Category:	To engineers spec.	
6		CA 1.0 CA 1.1	26/05/2017 19/06/2017	ВЈН	Project Issue Date:	19/06/2017	
			19/06/2017	BJH	Checked/Signed By Director:	Bradley Hunt	building designor association of

DRAWING LIST

Sheet Name	Current Revision Date
Title Page	19/06/2017
Perspectives	19/06/2017
Site Plan	19/06/2017
Ground Floor	19/06/2017
First Floor	19/06/2017
Second Floor	19/06/2017
Elevations	19/06/2017
Elevations	19/06/2017
Sections	19/06/2017
Acoustic Compliance	19/06/2017
	19/06/2017
	Title Page Perspectives Site Plan Ground Floor First Floor Second Floor Elevations Elevations

GENERAL INFORMATION

Construction of this building to be in accordance with the following Australian governing bodies.

- ◆ National Construction Code (NCC)
- ◆ Queensland Development Code
- ◆ Standard Building Regulation 2006
- ◆ Local government planning policies
- ◆ Estate Design Guidelines

Roof Construction

Colorbond sheet metal to be fixed in accordance with manufactures specification.

All ridge capping, steps, hips valleys and vent flashings to provide waterproofing system.

Provide reflective foil backed sarking to underside of roof sheeting. Colorbond guttering and PVC Downpipes to be connected to Stormwater systems in accordance with the local authority.

Roof water requirements and calculations are provided as a guide. Ensure a qualified plumber/ hydraulics consultant reviews the downpipe layouts prior to construction.

Icon Building Design has provided downpipe locations as a guide only. Layout to be checked for compliance by qualified persons prior to ordering and construction.

All slotted gutters and downpipes to be installed to NCC and or AS3500 (relevant parts). Materials used are to be compatible with all components upstream and down stream.

Surface water drainage must be prevented from entering the building with FGL sloping away from the building & finished slab levels. The builder is responsible to check all existing services prior to beginning construction.

Position of proposed building to be verified by builder on site. Location of existing services to be verified by builder prior to construction.


Termite method to be in accordance with the NCC Part 3.1.3 and other relevant manufacturer specification. All new work shall be protected from termite attack in accordance with AS 3600.1 "Protection of the Building from Subterranean Termites AS2870 Part 1 New Building Slabs.

Sheet Number:01

Project Number:17-023


Title Page

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Project Status:	Working Drawing 1.0	Scale: 1 : 100
Drawn By:	BJH	QBCC LIC# 1262

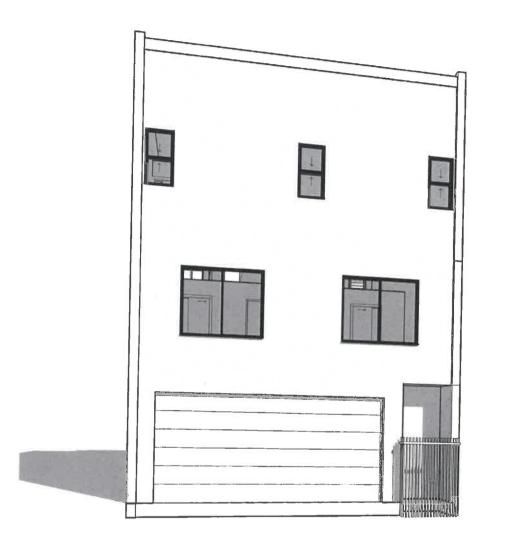

PROPOSED REAR PERSPECTIVE

Indicative image - survey required to accurately represent the proposed building on site.

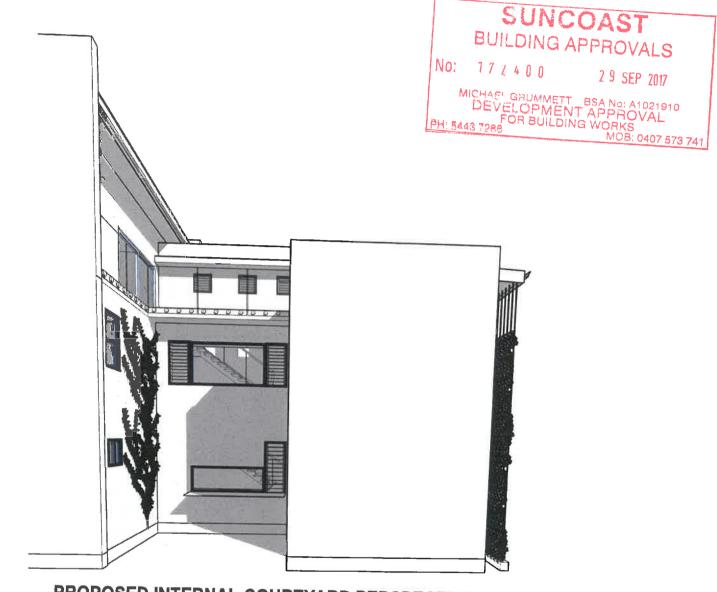

PROPOSED INTERNAL COURTYARD PERSPECTIVE

Indicative image - survey required to accurately represent the proposed building on site.

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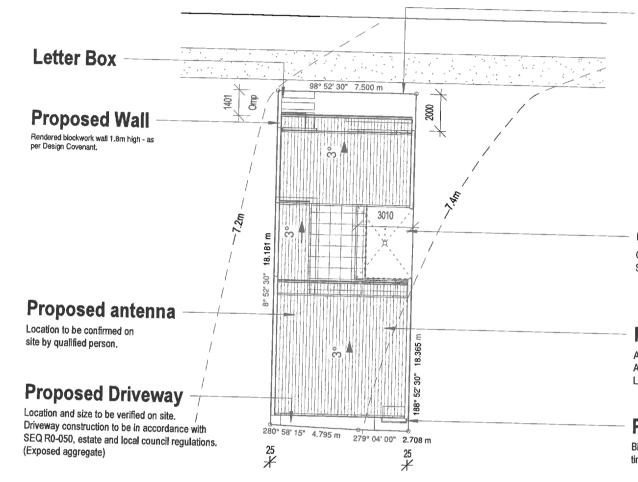
	Revision Schedule		Client Name:	Nothling Building Group		
Revision Number	Revision Description	Revision Date	Issued by	1		
<u> </u>	PCD 2.0	30/03/2017	BJH	Project Address:	Lot 43 Tinnanbar Terrace	
l	PCD 3.0	16/05/2017	BJH	Climate Zone:	2	
	PCD 4.0	23/05/2017	ВЈН	Wind Category:	To engineers spec.	
	CA 1.0	26/05/2017	BJH	Project Issue Date:		
	CA 1.1	19/06/2017	BJH	01 1 1/01	19/06/2017	
				Checked/Signed By Director:	Bradley Hunt	building designe association o queensland in

Sheet Number:02	Project Number:17-023
Perspectives	

2 9 SEP 2017

Perspectives Project Status: Working Drawing 1.0 Scale: Drawn By: BJH QBCC LIC# 126221

TINNANBAR TERRACE



OFWATER DISCHARGE TO:

□DISPERSE ON SITE □INTER ALLOTMENT DRAINAGE PIT ☐RAINWATER STORAGE TANKS ☐TO EXISTING APPROVED SYSTEM

- STORMWATER TO BE DISCHARGED SO AS TO NOT CAUSE NUISANCE TO ADJOINING OWNERS
- STORMWATER SYSTEM TO COMPLY WITH AS3500 PART 3
- ALL OTHER DETAILS TO LOCAL GOVERNMENT. REQUIREMENTS

Proposed Landscaping

Planting to include: 2 x 1.5m trees at time of planting. Pandanus sp. Small native grasses including lomandra sp. Native hedging Lilly pillies Stained timber retaining to garden beds Minimum 60% Garden Beds Remaining to be turf.

Outdoor living space

Ground floor area: 23m² Second floor balcony: 16.9m²

Proposed Residence

Approximate Pad RL 7.4m TBC Approximate FFL RL 7.625m TBC Location and size to be verified on site.

Proposed Bin Storage

Bins located behind 1800 high timber gate screened from view,

DUNDOWRAN LANE

Builder to ensure surface water is to fall away from the proposed building and prevent pooling in excavated locations.

2 x 1.5m "Pandanus"

Native hedging "Lilly Pilly"

Native Grasses "Lomandra"

SUNCOAST BUILDING APPROVALS

No: 172400

2 9 SEP 2017

MICHAEL GRUMMETT BSA No: A1021910
DEVELOPMENT APPROVAL
FOR BUILDING WORKS
5443 7288 MOB: 0407 578 744

County of Canning Area: 137 m² Site Cover: NA Local Authority: Sunshine Coast Regional Council.

Real Property Description Lot 43 on S.P. 284339

Parish of Mooloolah

NORTH

Climate Code Requirements Energy efficiency assessor to confirm adequacy of proposed construction. Provide insulation to N.C.C. code requirements or to BERS certification requirements,

Stormwater Note

All stormwater drainage shall be in accordance with A.S. 3500.3.

All stormwater drainage shall be in accordance with S.C.C. guidelines to minimise erosion and scouring. Stormwater flow other than natural overland flow shall not be discharged onto neighboring property.

All stormwater drainage design is preliminary and shall be confirmed by a licensed hydraulics

PROPOSED SITE PLAN

Scale 1:200 @ A3

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BUILDING DESIGN	3


© COPYRIGHT The Drawing and the design depicted on this sheet remains the pro	Revision So	chedule		A44	Nothling Building Group	
	Revision Number Revision Description	Revision Date	Issued by			
BUILDING DESIGN 3	PCD 2.0	30/03/2017	BJH	Project Address:	Lot 43 Tinnanbar Terrace	
DOILDING DESIGN 3	PCD 3.0	16/05/2017	ВЈН	Climate Zone:	2	
Email: bradley.hunt@iconbuildingdesign.com.au 4	PCD 4.0	23/05/2017	BJH	Wind Category:	To ongine and	
website: www.iconbuildingdesign.com.au 5	CA 1.0	26/05/2017	ВЈН		To engineers spec.	
Phone: 0488209840 6	CA 1.1	19/06/2017	B.11.	Project Issue Date:	19/06/2017	
				Checked/Signed By Director:	Bradley Hunt	but/fring designers' association of

Sheet Number:03

Project Number:17-023

Site Plan

Project Status:	Working Drawing 1.0	Scale: As indicated
Drawn By:	ВЈН	QBCC LIC# 1262

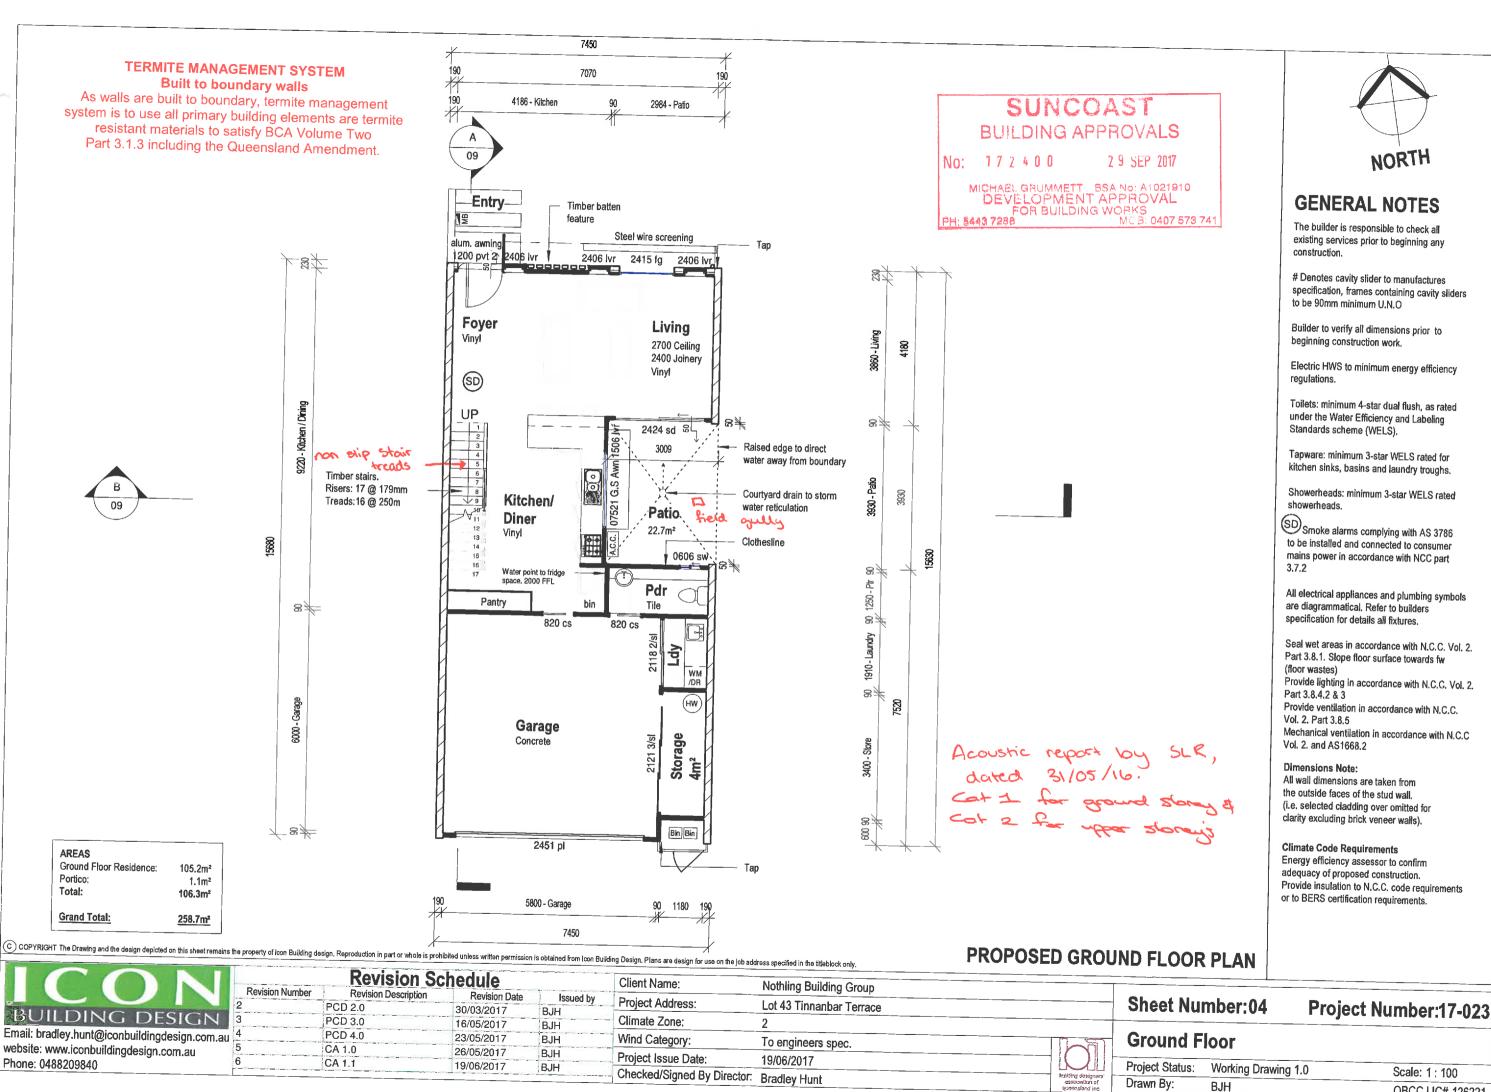

NORTH

Scale: 1: 100

QBCC LIC# 126221



SUNCOAST **BUILDING APPROVALS**

No: 172400

2 9 SEP 2017

MICHAEL GRUMMETT BSA No: A1021910 DEVELOPMENT APPROVAL FOR BUILDING WORKS MOB: 0407 573 741



GENERAL NOTES

The builder is responsible to check all existing services prior to beginning any construction.

Denotes cavity slider to manufactures specification, frames containing cavity sliders to be 90mm minimum U.N.O

Builder to verify all dimensions prior to beginning construction work.

Electric HWS to minimum energy efficiency regulations.

Toilets: minimum 4-star dual flush, as rated under the Water Efficiency and Labeling Standards scheme (WELS).

Tapware: minimum 3-star WELS rated for kitchen sinks, basins and laundry troughs.

Showerheads: minimum 3-star WELS rated showerheads

SD Smoke alarms complying with AS 3786 to be installed and connected to consumer mains power in accordance with NCC part 3.7.2

All electrical appliances and plumbing symbols are diagrammatical. Refer to builders specification for details all fixtures.

Seal wet areas in accordance with N.C.C. Vol. 2. Part 3.8.1. Slope floor surface towards fw (floor wastes) Provide lighting in accordance with N.C.C. Vol. 2. Part 3.8.4.2 & 3 Provide ventilation in accordance with N.C.C. Vol. 2. Part 3.8.5 Mechanical ventilation in accordance with N.C.C

Dimensions Note:


Vol. 2. and AS1668.2

All wall dimensions are taken from the outside faces of the stud wall. (i.e. selected cladding over omitted for clarity excluding brick veneer walls).

Climate Code Requirements Energy efficiency assessor to confirm adequacy of proposed construction. Provide insulation to N.C.C. code requirements or to BERS certification requirements.

PROPOSED FIRST FLOOR PLAN

	The state of the s			OIT IS ODIZINED ITOST TOOL BUILD	oing Design. Plans are design for use on the job ad	dress specified in the titleblock only.			
	Revision Number	Revision Sc			Client Name:	Nothling Building Group			
	2 IDOD	Revision Description 2.0	Revision Date 30/03/2017	Issued by BJH	Project Address:	Lot 43 Tinnanbar Terrace		Sheet Number:05	Project Number:17-023
BUILDING DESIGN	PCD		16/05/2017	ВЈН	Climate Zone:	2			1.10,000 1141111501.17-023
Email: bradley.hunt@iconbuildingdesign.com.au website: www.iconbuildingdesign.com.au	PCD CA 1		23/05/2017	ВЈН	Wind Category:	To engineers spec.		First Floor	
Phone: 0488209840	GA 1		26/05/2017 19/06/2017	BJH	Project Issue Date:	19/06/2017		Project Status: Working Drawing	0.10
					Checked/Signed By Director:	Bradley Hunt	building designers' association of queensland inc	Drawn By: BJH	5
							draguzielia M.C.		QBCC LIC# 126221

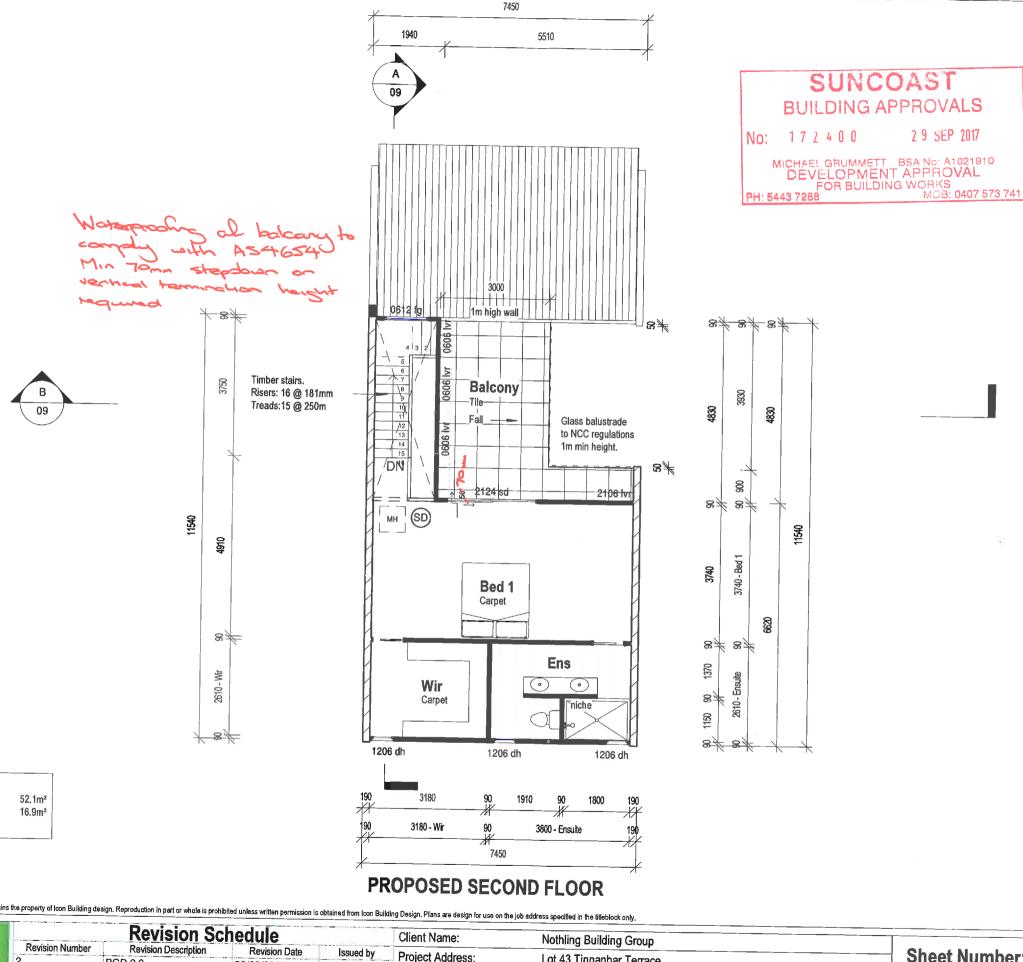



GENERAL NOTES

The builder is responsible to check all existing services prior to beginning any construction.

Denotes cavity slider to manufactures specification, frames containing cavity sliders to be 90mm minimum U.N.O

Builder to verify all dimensions prior to beginning construction work.

Electric HWS to minimum energy efficiency regulations.

Toilets: minimum 4-star dual flush, as rated under the Water Efficiency and Labeling Standards scheme (WELS).

Tapware: minimum 3-star WELS rated for kitchen sinks, basins and laundry troughs.

Showerheads: minimum 3-star WELS rated showerheads.

SD Smoke alarms complying with AS 3786 to be installed and connected to consumer mains power in accordance with NCC part 3.7.2

All electrical appliances and plumbing symbols are diagrammatical. Refer to builders specification for details all fixtures.

Seal wet areas in accordance with N.C.C. Vol. 2. Part 3.8.1, Slope floor surface towards fw (floor wastes) Provide lighting in accordance with N.C.C. Vol. 2. Part 3.8.4.2 & 3 Provide ventilation in accordance with N.C.C. Vol. 2. Part 3.8.5

Mechanical ventilation in accordance with N.C.C Vol. 2. and AS1668.2

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AREAS

Second Floor Residence:

Second Floor Balcony:

(excludes voids)

	Revision So	chedule		Client Name:	Nothling Building Group	
Revision Number	Revision Description	Revision Date	Issued by			
	PCD 2.0	30/03/2017	BJH		Lot 43 Tinnanbar Terrace	
	PCD 3.0	16/05/2017	BJH	Climate Zone:	2	
	PCD 4.0	23/05/2017	ВЈН	Wind Category:	To engineers spec.	
	CA 1.0	26/05/2017	ВЈН	Project Issue Date:		
	CA 1.1	19/06/2017	BJH		19/06/2017	
				Checked/Signed By Director:	Bradley Hunt	building de associa

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Project Number:17-023

Second	Floor
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2 9 SEP 2017

Project Status:	Working Drawing 1.0	Scale: 1:100
Drawn By:	ВЈН	OBCC LIC# 1262



Rendered FC Sheet. To engineer's specification. (Polished Render)

Aluminum framed windows to manufacturers specification. (Monument Black)

Colorbond Trimdek roof sheeting fixed to manufacturers specification for wind category. (3° pitch). (Surfmist)

Colorbond slotted gutter, fascia to match roofing. Fix to manufacturers specification. (Surfmist)

Rendered block work. To engineer's specification. (Dulux Timeless Grey)

Cedar feature panel detail. Fix to manufacturers specification.

Rendered brick veneer wall. To engineer's specification. (Polished render)

Solid aluminum awning detail to manufacturers specification. (Dulux Timeless Grey)

S/S Wire feature screen detail. Fix to manufacturers specification. Solid blue steel door to

manufacturers specification. Approx. finished Ground Line MICHAEL GRUMMETT BSA No: A1021910
DEVELOPMENT APPROVAL
FOR BUILDING WORKS
MCB: 0407 573 741

No: 172400

SUNCOAST

BUILDING APPROVALS

All security doors and insect screens


fitted to external doors and windows are to be wire mesh only. Honeycomb

or similarly reinforced security screens

are not permitted.

2 9 SEP 2017

STREET FRONT ELEVATION

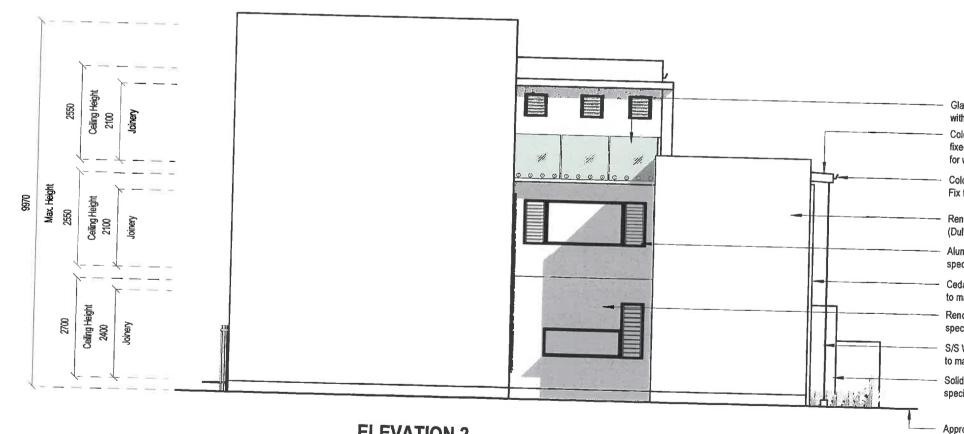

Glass balustrade fixed in accordance with manufacturers specification.

Colorbond Trimdek roof sheeting fixed to manufacturers specification for wind category. (3° pitch). (Surfmist)

Colorbond slotted gutter, fascia to match roofing. Fix to manufacturers specification. (Surfmist)

Rendered block work. To engineer's specification. (Dulux Timeless Grey as needed)

Aluminum framed windows to manufacturers specification. (Monument Black)

Cedar feature panel detail. Fix to manufacturers specification.

Rendered FC sheet. To engineer's specification. (Polished render)

S/S Wire feature screen detail. Fix to manufacturers specification.

Solid aluminum awning detail to manufacturers specification. (Dulux Timeless Grey)

Approx. finished Ground Line

ELEVATION 2

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BUILDING DESIGN	3
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website: www.iconbuildingdesign.com.au	5
Phone: 0488209840	6


Revision Number	Revision So			Client Name:	Nothling Building Group		
2	PCD 2.0	Revision Date 30/03/2017	Issued by	Project Address:	Lot 43 Tinnanbar Terrace		S
3	PCD 3.0	16/05/2017	BJH	Climate Zone:	2		<u> </u>
1 6	PCD 4.0	23/05/2017	BJH	Wind Category:	To engineers spec.		F
6	CA 1.0 CA 1.1	26/05/2017 19/06/2017	BJH	Project Issue Date:	19/06/2017		
		19/00/2017	BJH	Checked/Signed By Director:	Bradley Hunt	buikting designers' association of	Pro

Sheet Number:07

Project Number:17-023

Elevations

	Working Drawing 1.0	Scale: 1: 100
Drawn By:	ВЈН	QBCC LIC# 126221
		QDOO LIG# 120221

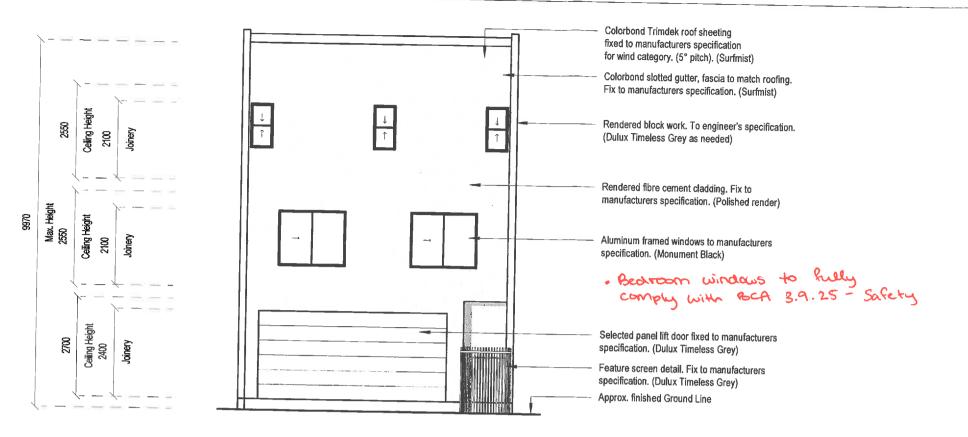

Note:

All security doors and insect screens fitted to external doors and windows are to be wire mesh only. Honeycomb or similarly reinforced security screens are not permitted.


SUNCOAST BUILDING APPROVALS

No: 172400

2 9 SEP 2017

MICHAEL GRUMMETT BSA No: A1021910
DEVELOPMENT APPROVAL
FOR BUILDING WORKS
PH: 5443 7288 MOB: 0407 573 741

REAR ELEVATION

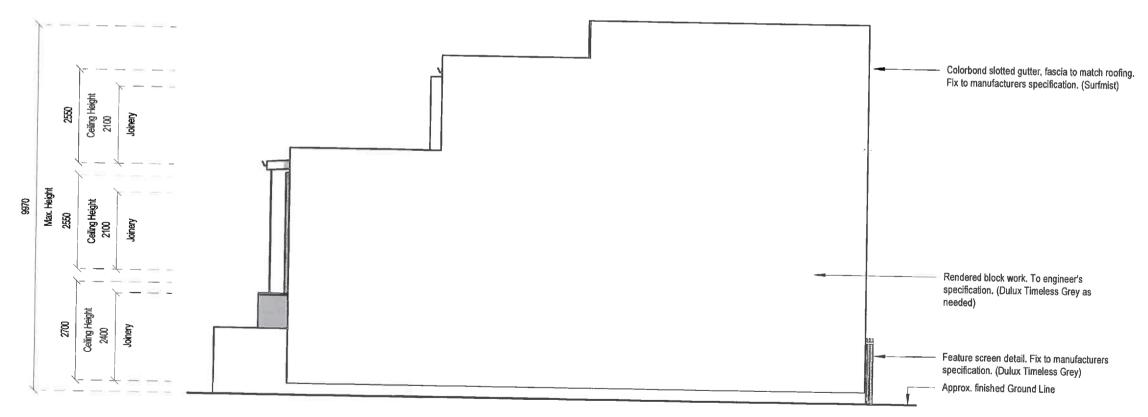

ELEVATION 4

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website: www.iconbuildingdesign.com.au	1

Phone: 0488209840


Revision Schedule				Nothling Ruilding Group	
	Revision Date	Issued by			
	30/03/2017	BJH	·	Lot 45 Tillianual Terrace	
PCD 3.0	16/05/2017	BJH	Climate Zone:	2	
PCD 4.0	23/05/2017	BJH	Wind Category:	To engineers spec	
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CA 1.1	19/06/2017	ВЛН			
			Checked/Signed By Director:	Bradley Hunt	building designers' association of
	PCD 2.0 PCD 3.0 PCD 4.0 CA 1.0	Revision Description Revision Date PCD 2.0 30/03/2017 PCD 3.0 16/05/2017 PCD 4.0 23/05/2017 CA 1.0 26/05/2017	Revision Description Revision Date Issued by PCD 2.0 30/03/2017 BJH PCD 3.0 16/05/2017 BJH PCD 4.0 23/05/2017 BJH CA 1.0 26/05/2017 BJH	Revision Description Revision Date Issued by Project Address: PCD 2.0 30/03/2017 BJH Climate Zone: PCD 3.0 16/05/2017 BJH Wind Category: PCD 4.0 23/05/2017 BJH Wind Category: CA 1.0 26/05/2017 BJH Project Issue Date:	Revision Description Revision Date Issued by Project Address: Lot 43 Tinnanbar Terrace


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Project Number:17-023

Elevations

Project Status:	Working Drawing 1.0	Scale: 1:100
Drawn By:	ВЈН	QBCC LIC# 126221



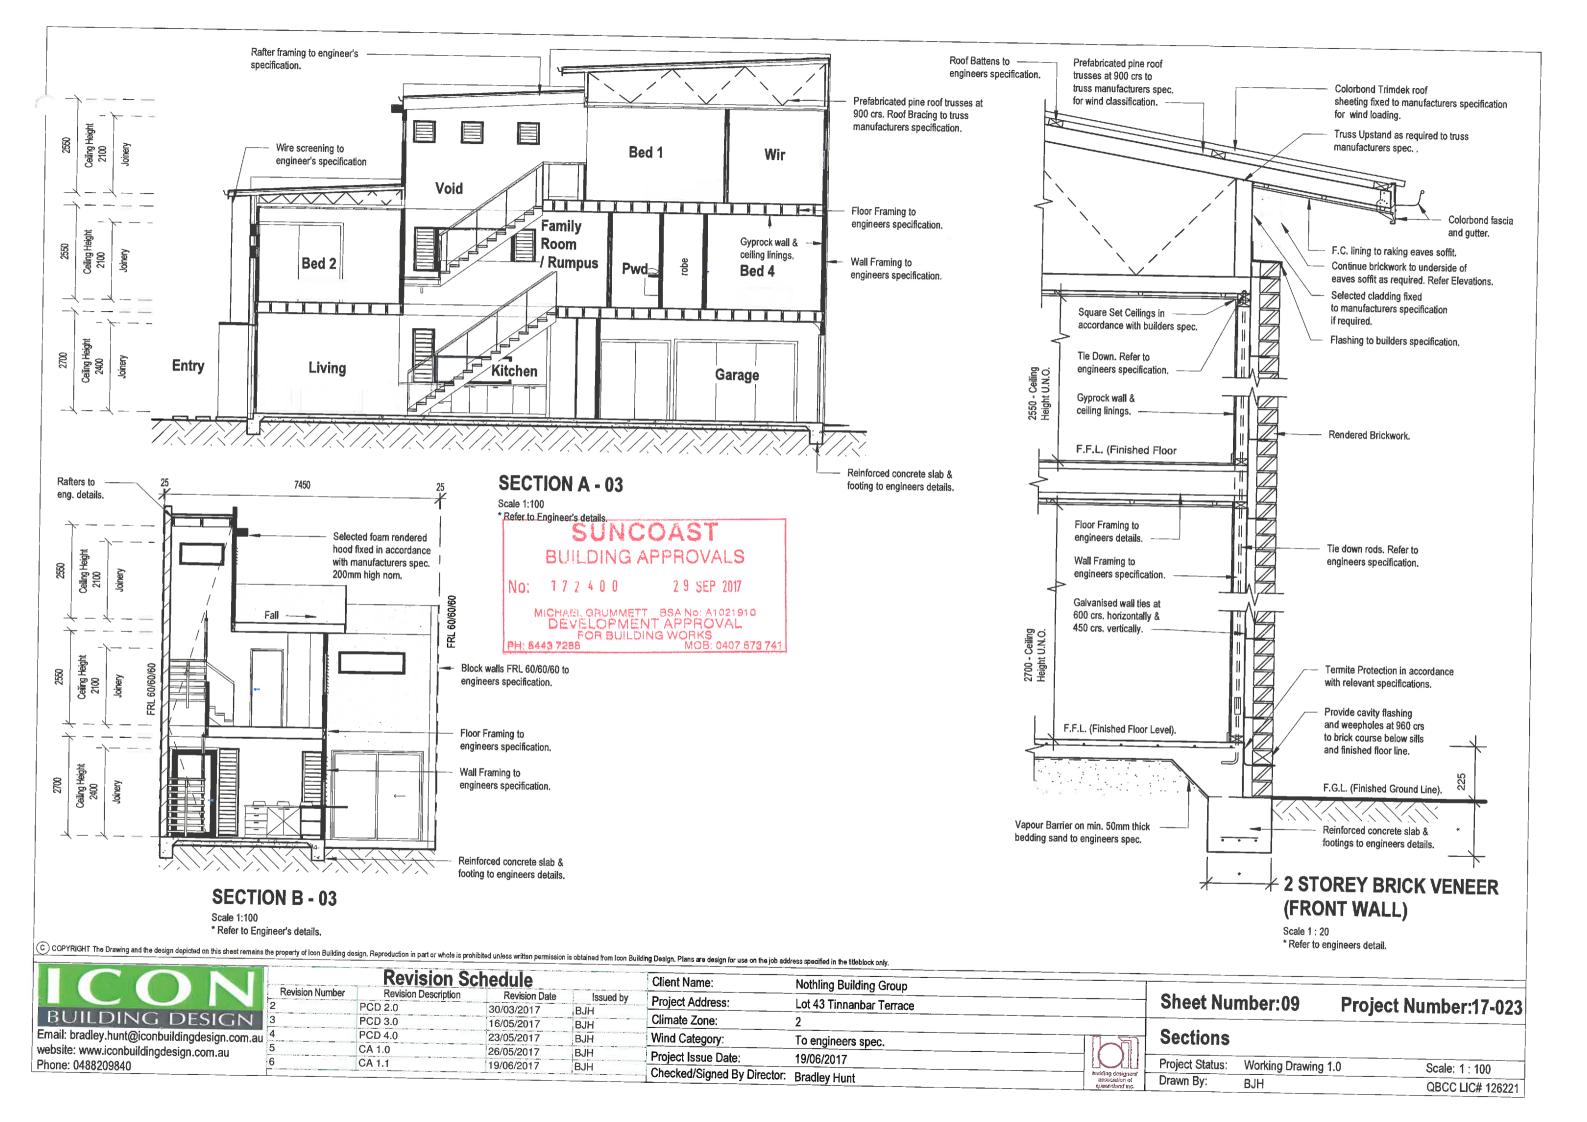


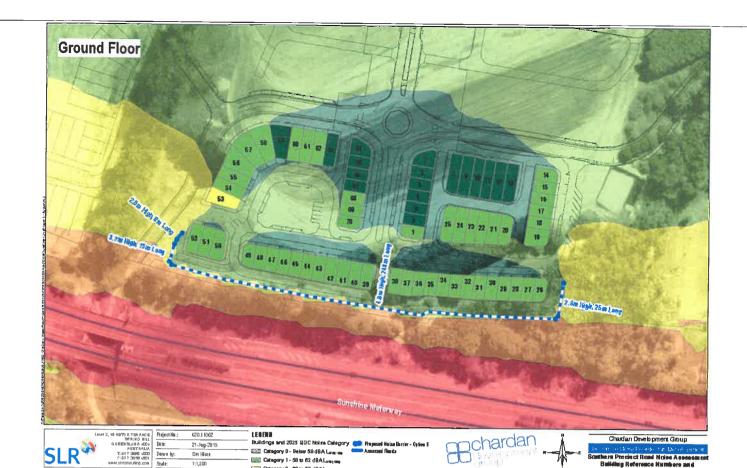Noise category	Minimum transport noise reduction (dB (A)) required for habitable rooms	Component of building's external envelope	Minimum R _* required for each component
		Glazing	35 (where total area of glazing for a <i>habitable room</i> is greater than 1.8m²)
		Olazing .	32 (where total area of glazing for a <i>habitable room</i> is less than or equal to 1.8m²)
Category 2	30	External walls	41
2nd Stoney	SUNC	Roof AST	38
2nd Storay	BUILDING A	FOR ROVALS	45
	No: 172400	Entry doors	33
	MICHAEL GRUMMETT DEVELOPMEN	BSA No: A1021910	27 (where total area of glazing for a <i>habitable room</i> is greater than 1.8m²)
Catagon, A	FOR BUILDI PH: 5443 7288	NG WORKS MOB: 0407 573 74	24 (where total area of glazing for a habitable room is less than or equal to 1.8m²)
Category 1	25	External walls	35
Ground		Roof	35
S		Entry Doors	28
Category 0	No additional acou	stic treatment required – standa	ard building assessment provisions apply.

- 🗀 Category 2 - 63 to 67 dBAL.warm

Queensland Development Code Publication Date: 10 August 2010

Buildings in a Transport Noise Corridor C COPYRIGHT The Drawing and the design depicted on this sheet remains the property of Icon Building design. Reproduction in part or whole is prohibited unless written permission is obtained from Icon Building Design. Plans are design for use on the job address specified in the titleblock only

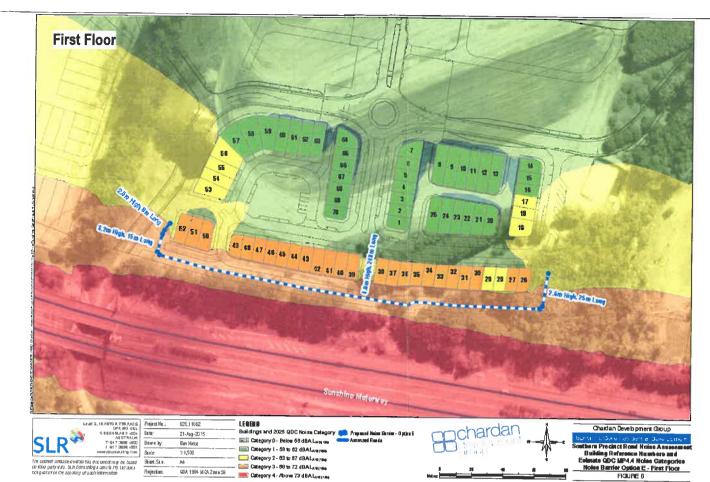

Noise category	Minimum transport noise reduction (dB (A)) required for habitable rooms	Component of building's external envelope	Minimum $R_{ m w}$ required for each component
		Glazing	43
		External walls	52
Category 4	40	Roof	45
		Floors	51
		Entry doors	35
	36	Glazing	38 (where total area of glazing for a <i>habitable room</i> is greater than 1.8m²)
			35 (where total area of glazing for a <i>habilable room</i> is less than or equal to 1.8m²)
Category 3		External walls	47
		Roof	41
		Floors	45
		Entry doors	33

Queensland Development Code Publication Date: 10 August 2010

Buildings in a Transport Noise Corridor

Note: Construction to comply with Acoustic Report by SLR Roted 31/5/2016. Min Category I for ground stoney & Category ?

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Revision Schedule			Client Name:	Nothling Building Group		_ Т	
Revision Number	Revision Description	Revision Date	Issued by	Project Address:	Lot 43 Tinnanbar Terrace		+
CA 1.1	CA 1.1 19/06/2017	BJH	Climate Zone:	2		†	
				Wind Category:	To engineers spec.		1
				Project Issue Date:	19/06/2017		-
				Checked/Signed By Director:	Bradley Hunt	building designers' association of gueensland inc.	ŀ

Sheet	Number:16	Project Number:17-023	

Acoustic Compliance

Project Status:	Working Drawing 1.0	Scale:
Drawn By:	ВЈН	QBCC LIC# 126221

Component of building's external envelope	Minimum R.	Acceptable forms of construction
	43	Double glazing consisting of two panes of minimum 5mm thick glass with at least 100mm air gap and full perimeter acoustically rated seats.
	38	Minimum 14.38mm thick laminated glass, with full perimeter acoustically rated seals; OR Double glazing consisting of one pane of minimum 5mm thick glass and one pane of minimum 6mm thick glass with at least 44mm air gap, and full perimeter acoustically rated seals
Glazing	35	Minimum 10.38mm thick laminated glass, with full perimeter acoustically rated seals.
	32	Minimum 6.39mm thick laminated glass with full perimeter acoustically rated seals.
	27	Minimum 4mm thick glass with full perimeter acoustically rated seals
	24	Minimum 4mm thick glass with standard weather seals

Queensland Development Code Publication Date: 10 August 2010

Buildings in a Transport Noise Corridor

Component of building's external envelope	Minimum R.,	Acceptable forms of construction
	52	Two leaves of clay brick masonry, at least 270mm in total, with subfloor vents fitted with noise attenuators.
External walls		Two leaves of clay brick masonry at least 110mm thick with: (i) cavity not less than 50mm between leaves; and (ii) 50mm thick mineral insulation or 50mm thick glass wool insulation with a density of 11kg/m³ or 50mm thick polyester insulation with a density of 20kg/m³ in the cavity.
	47	Two leaves of clay brick masonry at last 110mm thick with: (i) cavity not less than 50mm between leaves; and (ii) at least 13mm thick cement render on each face OR
		Single leaf of clay brick masonry at least 110mm thick with: (i) a row of at least 70mm x 35mm timber studs or 64mm steel studs at 600mm centres, spaced at least 20mm from the masonry wall; and (ii) Mineral insulation or glass wool insulation at least 50mm thick with a density of at least 11 kg/m³ positioned between studs; and (iii) One layer of plasterboard at least 13mm thick fixed to outside face of studs.
		OR Single leaf of minimum 150mm thick masonry of hollow, dense concrete blocks, with mortar joints laid to prevent moisture bridging.

Queensland Development Code Publication Date: 10 August 2010

MP 4.4 Buildings in a Transport Noise Corridor

60/60/60 90/90/90* (from both sides) *ACR Group 3

FAR2303

Phone: 0488209840



EXI	FERNAL WALL SIDE
+ 1	x 6mm CeminSeal
V	Nallbo <i>a</i> rd (against frame
	l x 16mm Gyprock Fyrchek MR Plasterboar
INT	ERNAL WALL SIDE

EXTERNAL WALL SIDE 1 x 6mm CeminSeal	(a) 75 C
Wallboard (against frame)	(b) 90 G
 1 x 16mm Gyprock Fyrchek MR Plasterboard. 	
INTERNAL WALL SIDE	(d) 90 G
 2 x 13mm Gyprock Fyrchek Plasterboard. 	P

(a) 75 Gold Batts R1.5	49/41	1.9	2.0
(b) 90 Gold Batts R2.0	49/41	2.2	2.4
(d) 90 Gold Batts R2.5	60/42	2.8	2.9
Min, Wall Thickness mm	148		

SUNCOAST

BUILDING APPROVALS

No: 172400

2 9 SEP 2017

MICHAEL GRUMMETT BSA No: A1021910
DEVELOPMENT APPROVAL
FOR BUILDING WORKS
PH: 5443 7288 MOB: 0407 573 741

Component of building's external envelope	Minimum R.	Acceptable forms of construction
	95	Single leaf of clay brick masonry at least 110mm thick with: (i) a row of at least 70mm x 35mm timber studs or 64mm steel studs at 600mm centres, spaced at least 20mm from the masonry wall; and (ii) One layer of plasterboard at least 10mm thick fixed to outside face of studs OR
		Minimum 6mm thick fibre cement sheeting or weatherboards or plank cladding externally, minimum 90mm deep timber stud or 92mm metal stud, standard plasterboard at least 13mm thick internally.
		Concrete or terracotta tile or sheet metal roof with sarking, acoustically rated plasterboard ceiling at least 13mm thick fixed to ceiling joists, cellulose fibre insulation at least 100mm thick with a density of at least 45kg/m³ in the cavity.
Roof	45	OR
		Concrete or terracotta tile or sheet metal roof with sarking, 2 layers of acoustically rated plasterboard at least 18mm thick fixed to ceiling joists, glass wool insulation at least 50mm thick with a density of at least 11kg/m³ or polyester insulation at least 50mm thick with a density of at least 20kg/m³ in the cavity.
	41	Concrete or terracotta tile or metal sheet roof with sarking, plasterboard ceiling at least 10mm thick fixed to ceiling joists, glass wool insulation at least 50mm thick with a density of at least 11kg/m³ or polyester insulation at least 50mm thick with a density of at least 20kg/m³ in the cavity.
		OR
		Concrete suspended slab at least 100mm thick.
	38	Concrete or terracotta tile or metal sheet roof with sarking, plasterboard ceiling at least 10mm thick fixed to ceiling cavity, mineral insulation or glass wool insulation at least 50mm thick with a density of at least 11 kg/m ² .

Queensland Development Code Publication Date: 10 August 2010

MP 4.4 Buildings in a Transport Noise Corridor

building's external envelope	Minimum R.	Acceptable forms of construction
e1	35	Concrete or terracotta tile or metal sheet roof with sarking, plasterboard ceiling at least 10mm thick fixed to ceiling cavity.
	51	Concrete slab at least 150mm thick.
Floors	45	Concrete slab at least 100mm thick OR Tongued and grooved boards at least 19mm thick with: (i) timber joists not less than 175mm x 50mm; and (ii) mineral insulation or glass wool insulation at least 75mm thick with a density of at least 11kg/m³ positioned between joists and laid on plasterboard at least 10mm thick fixed to underside of joists; and (iii) mineral insulation or glass wool insulation at least 25mm thick with a density of at least 11kg/m³ laid over entire floor, including tops of joists before flooring is laid; and (iv) secured to battens at least 75mm x 50mm; and (v) the assembled flooring laid over the joists, but not fixed to them, with battens lying between the joists.
Entry Doors	35	Solid core timber not less than 45mm thick, fixed so as to overlap the frame or rebate of the frame by not less than 10mm, with full perimeter acoustically rated seals.
	33	Fixed so as to overlap the frame or rebate of the frame by not less than 10mm, fitted with full perimeter acoustically refed seals and constructed of - (i) solid core, wood, particleboard or blockboard not less than 45mm thick; and/or (ii) acoustically laminated glass not less than 10.38mm thick.

Queensland Development Code Publication Date: 10 August 2010

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Buildings in a Transport Noise Corridor

Component of building's external envelope	Minimum R _u	Acceptable forms of construction
		Fixed so as to overlap the frame or rebate of the frame, constructed of -
		(i) Wood, particleboard or blockboard not less than 33mm thick; or
	28	(ii) Compressed fibre reinforced sheeting not less than 9mm thick; or
		(iii) Other suitable material with a mass per unit area not less than 24.4kg/m²; or
		(iv) Solid core timber door not less than 35mm thick fitted with full perimeter acoustically rated seals.

Drawn By:

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Revision Number	Revision Description	Revision Date	Issued b
6	CA 1.1	19/06/2017	BJH

Client Name:	Nothling Building Group	
Project Address:	Lot 43 Tinnanbar Terrace	
Climate Zone:	2	
Wind Category:	To engineers spec.	
Project Issue Date:	19/06/2017	
Checked/Signed By Director:	Bradley Hunt	building designers' association of queensland inc

Sheet Number:17	Project Number:17-023
Acoustic Compliance	
Project Status: Working Drawing 1	.0 Scale:

QBCC LIC# 126221